

|      | LIST OF DRAWINGS (MAKHU TOWN)                                |                        |      |
|------|--|------------------------|------|
| S.NO | . DRAWING TITLE  | DRAWING NO.            | REV. |
| GE   | ENERAL .   |                        |      |
| 1    | List of Drawings   | FPI_HW_DD_DWG_GEN_1000 | R3   |
| 2    | Horizontal Curve Details                                     | FPI_HW_DD_DWG_GEN_1005 | R2   |
| 3    | Application of Typical Cross Section                         | FPI_HW_DD_DWG_GEN_1014 | R3   |
| TY   | PICAL CROSS SECTION  |                        |      |
| 1    | Typical Cross Section (TCS-1 and TCS-2)                      | FPI_HW_DD_DWG_TCS_1025 | R3   |
| 2    | Typical Cross Section (TCS-3 and TCS-4a)                     | FPI_HW_DD_DWG_TCS_1026 | R3   |
| 3    | Typical Cross Section (TCS-4b)                               | FPI_HW_DD_DWG_TCS_1027 | R3   |
| PL   | AN & PROFILE   |                        |      |
| 1    | Alignment Plan and Profile (km 170+000 to km 170+500)        | FPI_HW_DD_RG_AP_1100   | R3   |
| 2    | Alignment Plan and Profile (km 170+500 to km 171+000)        | FPI_HW_DD_RG_PP_1101   | R3   |
| 3    | Alignment Plan and Profile (km 171+000 to km 170+500)        | FPI_HW_DD_RG_PP_1102   | R3   |
| 4    | Alignment Plan and Profile (km 171+500 to km 171+900)        | FPI_HW_DD_RG_PP_1103   | R3   |
| ST   | RUCTURE  |                        |      |
| 1    | Typical GAD of Box Culvert                                   | FPI_ST_DD_DWG_HZF_5001 | R3   |
| 2    | GAD For Minor Bridge at Prop. Ch. 171+575 For Reconstruction | FPI_ST_DD_DWG_HZF_5002 | R3   |
| 3    | GAD For ROB at Prop. Ch. 171+387.25 (2 Sheets)               | FPI_ST_DD_DWG_HZF_5003 | R3   |

| NOTES: | REFERENCE DWGS.: |      |          |                      |       |      |      | CI    |
|--------|------------------|------|----------|----------------------|-------|------|------|-------|
|        |                  |      |          |                      |       |      |      |       |
|        |                  |      |          |                      |       |      |      | ] [   |
|        |                  | R3   | 17/08/22 | FINAL DPR SUBMISSION | SPK   | CSB  | DMC  | L     |
|        |                  | R2   | 22/06/22 | FINAL DPR SUBMISSION | SPK   | CSB  | DMC  | ] c   |
|        |                  | R1   | 19/05/22 | FINAL DPR SUBMISSION | SPK   | CSB  | DMC  |       |
|        |                  | R0   | 11/03/22 | DPR SUBMISSION       | SPK   | CSB  | DMC  |       |
|        |                  | REV. | DATE     | DESCRIPTION          | DRAWN | СНК. | APP. | DISCL |
|        |                  |      |          | REVISION INDEX       |       |      |      | 1     |

### National Highways Authority of India (Ministry of Road Transport and Highways)

(Ministry of Road Transport and Highways) G-5 & 6, Sector-10, Dwarka, New Delhi - 110075.

consultant: FP Project Management

Formerly Frischmann Prabhu (India) Private Limited 315, Balgovind Wadi, New Prabhadevi Road, Prabhadevi, Mumbai - 400 025 Tel: +91-22-6660 3901 Fax: +91-22-6660 3902 E-mail: pfmumbai@fpindia.com www.fpindia.com

PROJECT:

WIDENING AND RECONSTRUCTION OF EXISTING TWO LANE CARRIAGEWAY TO FOUR LANE WITH PAVED SHOULDER INCLUDING CONSTRUCTION OF ROB IN MAKHU TOWN FROM KM. 170+000 TO KM. 171+900 OF NH-54 IN THE STATE OF PUNJAB ON EPC MODE

DRAWING TITLE: HARIKE - ZIRA - FARIDKOTE SECTION

LIST OF DRAWING

 SCALE:
 PROJECT No.:
 165007

 FPI
 HW
 DD
 HZF
 GEN
 1000
 R3

|         | Horizontal Curve Details - km 170+000 to km 171+900 |  |                  |             |                          |                      |              |                     |         |               |               |            |           |      |
|---------|---|--|------------------|-------------|--------------------------|----------------------|--------------|---------------------|---------|---------------|---------------|------------|-----------|------|
| Sr. No  | Curve No.   | HIP Co-ordinates  HIP Chainage Design Speed (kmph) Tangent Length (m) Curve Length Chord | Deflection Angle | Radius (m)  | Hand of Curve            | Transition           | n Length (m) | Super elevation (%) |         |               |               |            |           |      |
| 31. 110 | Curve No.   | Till Chamage   | Х                | Y           | _ besign speed (kilipii) | Tangent Length (III) | (m)          | Length (m)          | (d)     | rtadias (III) | Hand of Curve | Preceeding | Following |      |
| 1       | Curve No. 1   | 170077.421   | 497258.627       | 3442322.981 | 100                      | 42.346               | 84.689       | 84.688              | 000.970 | 5000          | RIGHT         | 0          | 0         | NC   |
| 2       | Curve No. 2   | 170631.414   | 497721.981       | 3442020.020 | 100                      | 234.221              | 444.842      | 433.831             | 044.326 | 575           | RIGHT         | 90         | 90        | 7.00 |
| 3       | Curve No. 3   | 171046.383   | 497785.761       | 3441586.401 | 100                      | 14.589               | 29.178       | 29.178              | 000.334 | 5000          | LEFT          | 0          | 0         | NC   |
| 4       | Curve No. 4   | 171198.166   | 497801.628       | 3441435.449 | 100                      | 5.979                | 11.958       | 11.958              | 000.137 | 5000          | RIGHT         | 0          | 0         | NC   |
| 5       | Curve No. 5   | 171328.368   | 497814.928       | 3441305.928 | 100                      | 46.493               | 92.983       | 92.982              | 001.066 | 5000          | LEFT          | 0          | 0         | NC   |
| 6       | Curve No. 6   | 171536.337   | 497840.017       | 3441099.475 | 100                      | 18.255               | 36.511       | 36.510              | 000.418 | 5000          | LEFT          | 0          | 0         | NC   |
| 7       | Curve No. 7   | 171724.303   | 497864.054       | 3440913.052 | 100                      | 8.524                | 17.047       | 17.047              | 000.195 | 5000          | LEFT          | 0          | 0         | NC   |

|    | NOTES:                                      | REFERENCE DWGS.: |      |          |                      |       |      |      | CL      |
|----|---|------------------|------|----------|----------------------|-------|------|------|---------|
| 1. | FOR HORIZONTAL CURVE NUMBER & LOCATION      |                  |      |          |                      |       |      |      |         |
|    | REFER DWG NO. FPI_HW_DD_HZF_PP_1100 TO 1103 |                  |      |          |                      |       |      |      | 聞       |
| 2. | NC: NORMAL CROSSFALL                        |                  |      |          |                      |       |      |      |         |
|    |   |                  | R2   | 17/08/22 | FINAL DPR SUBMISSION | SPK   | CSB  | DMC  | Co      |
|    |   |                  | R1   | 19/05/22 | FINAL DPR SUBMISSION | SPK   | CSB  | DMC  |         |
|    |   |                  | R0   | 11/03/22 | DPR SUBMISSION       | SPK   | CSB  | DMC  | 1       |
|    |   |                  | REV. | DATE     | DESCRIPTION          | DRAWN | СНК. | APP. | DISCLAI |
|    |   |                  |      |          | REVISION INDEX       |       |      |      |         |

# National Highways Authority of India (Ministry of Road Transport and Highways)

(Ministry of Road Transport and Highways) G-5 & 6, Sector-10, Dwarka, New Delhi - 110075.

CONSULTANT: FP Project Management

Formerty Frischmann Prabbu (India) Private Limited 315, Balgovind Wadi, New Prabhadevi Road, Prabhadevi, Mumbai - 400 025 Tel: +91-22-6660 3901 Fax: +91-22-6660 3902 E-mail: pfmumbai@fpindia.com www.fpindia.com

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PROJECT:

WIDENING AND RECONSTRUCTION OF EXISTING TWO LANE
CARRIAGEWAY TO FOUR LANE WITH PAVED SHOULDER INCLUDING
CONSTRUCTION OF ROB IN MAKHU TOWN FROM KM. 170+000 TO
KM. 171+900 OF NH-54 IN THE STATE OF PUNJAB ON EPC MODE

DRAWING TITLE : HARIKE - ZIRA - FARIDKOTE SECTION

HORIZONTAL CURVE DETAILS

 SCALE:
 PROJECT No.:
 165007

 FPI
 HW
 DD
 DWG
 GEN
 1005
 R2

|         | TCS APPLICATION |         |        |          |  |  |  |  |  |  |  |
|---------|-----------------|---------|--------|----------|--|--|--|--|--|--|--|
| Su No   | Cha             | inage   | Length | TCS      | Domonik  |  |  |  |  |  |  |
| Sr. No. | From            | То      | Length | TCS      | Remark   |  |  |  |  |  |  |
| 1       | 170+000         | 170+300 | 300    | TCS-1    | RECONSTRUCTION OF EXISTING CARRIAGEWAY — OPEN COUNTRY (CONCENTRIC WIDENING)  |  |  |  |  |  |  |
| 2       | 170+300         | 170+890 | 590    | TCS-2    | RECONSTRUCTION OF EXISTING CARRIAGEWAY — BUILT UP AREA (CONCENTRIC WIDENING) |  |  |  |  |  |  |
| 3       | 170+890         | 171+320 | 430    | TCS-3    | FOUR LANE ROB APPROACH WITH 4.0 M MEDIAN                                     |  |  |  |  |  |  |
| 4       | 171+320         | 171+340 | 20     | TCS-4(b) | FOUR LANE ROB APPROACH WITH 4.0 M MEDIAN                                     |  |  |  |  |  |  |
| 5       | 171+340         | 171+422 | 82     | TCS-4(a) | FOUR LANE ROB VIADUCT (RAILWAY PORTION)                                      |  |  |  |  |  |  |
| 6       | 171+422         | 171+556 | 134    | TCS-4(b) | FOUR LANE ROB VIADUCT (NON-RAILWAY PORTION)                                  |  |  |  |  |  |  |
| 7       | 171+556         | 171+900 | 344    | TCS-3    | FOUR LANE ROB APPROACH WITH 4.0 M MEDIAN                                     |  |  |  |  |  |  |

|    | NOTES:                                       | REFERENCE DWGS.: |      |          |                |       |      |      | CL    |
|----|--|------------------|------|----------|----------------|-------|------|------|-------|
| 1. | FOR TYPICAL CROSS SECTION DETAILS            |                  |      |          |                |       |      |      | 5     |
|    | REFER DWG NO. FPI_HW_DD_DWG_TCS_1025 TO 1027 |                  |      |          |                |       |      |      | 뮵     |
| 2. | REFER RELEVANT PLAN AND PROFILE DRAWINGS     |                  | R3   | 17/08/22 | DPR SUBMISSION | SPK   | CSB  | DMC  | L.    |
|    | FOR MORE DETAILS                             |                  | R2   | 22/06/22 | DPR SUBMISSION | SPK   | CSB  | DMC  | ] c   |
|    | REFER DWG NO. FPI_HW_DD_HZF_PP_1100 TO 1103  |                  | R1   | 19/05/22 | DPR SUBMISSION | SPK   | CSB  | DMC  | ĺ     |
|    |  |                  | R0   | 11/03/22 | DPR SUBMISSION | SPK   | CSB  | DMC  | ĺ     |
|    |  |                  | REV. | DATE     | DESCRIPTION    | DRAWN | СНК. | APP. | DISCL |
|    |  |                  |      |          | REVISION INDEX |       |      |      | ĺ     |

# National Highways Authority of India (Ministry of Road Transport and Highways)

(Ministry of Road Transport and Highways) G-5 & 6, Sector-10, Dwarka, New Delhi - 110075.

consultant: FP Project Management

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PROJECT:


WIDENING AND RECONSTRUCTION OF EXISTING TWO LANE
CARRIAGEWAY TO FOUR LANE WITH PAVED SHOULDER INCLUDING
CONSTRUCTION OF ROB IN MAKHU TOWN FROM KM. 170+000 TO
KM. 171+900 OF NH-54 IN THE STATE OF PUNJAB ON EPC MODE


DRAWING TITLE: HARIKE - ZIRA - FARIDKOTE SECTION

APPLICATION OF TYPICAL CROSS SECTION


 SCALE:
 PROJECT No.:
 165007

 FPI
 HW
 DD
 HZF
 GEN
 1014
 R3

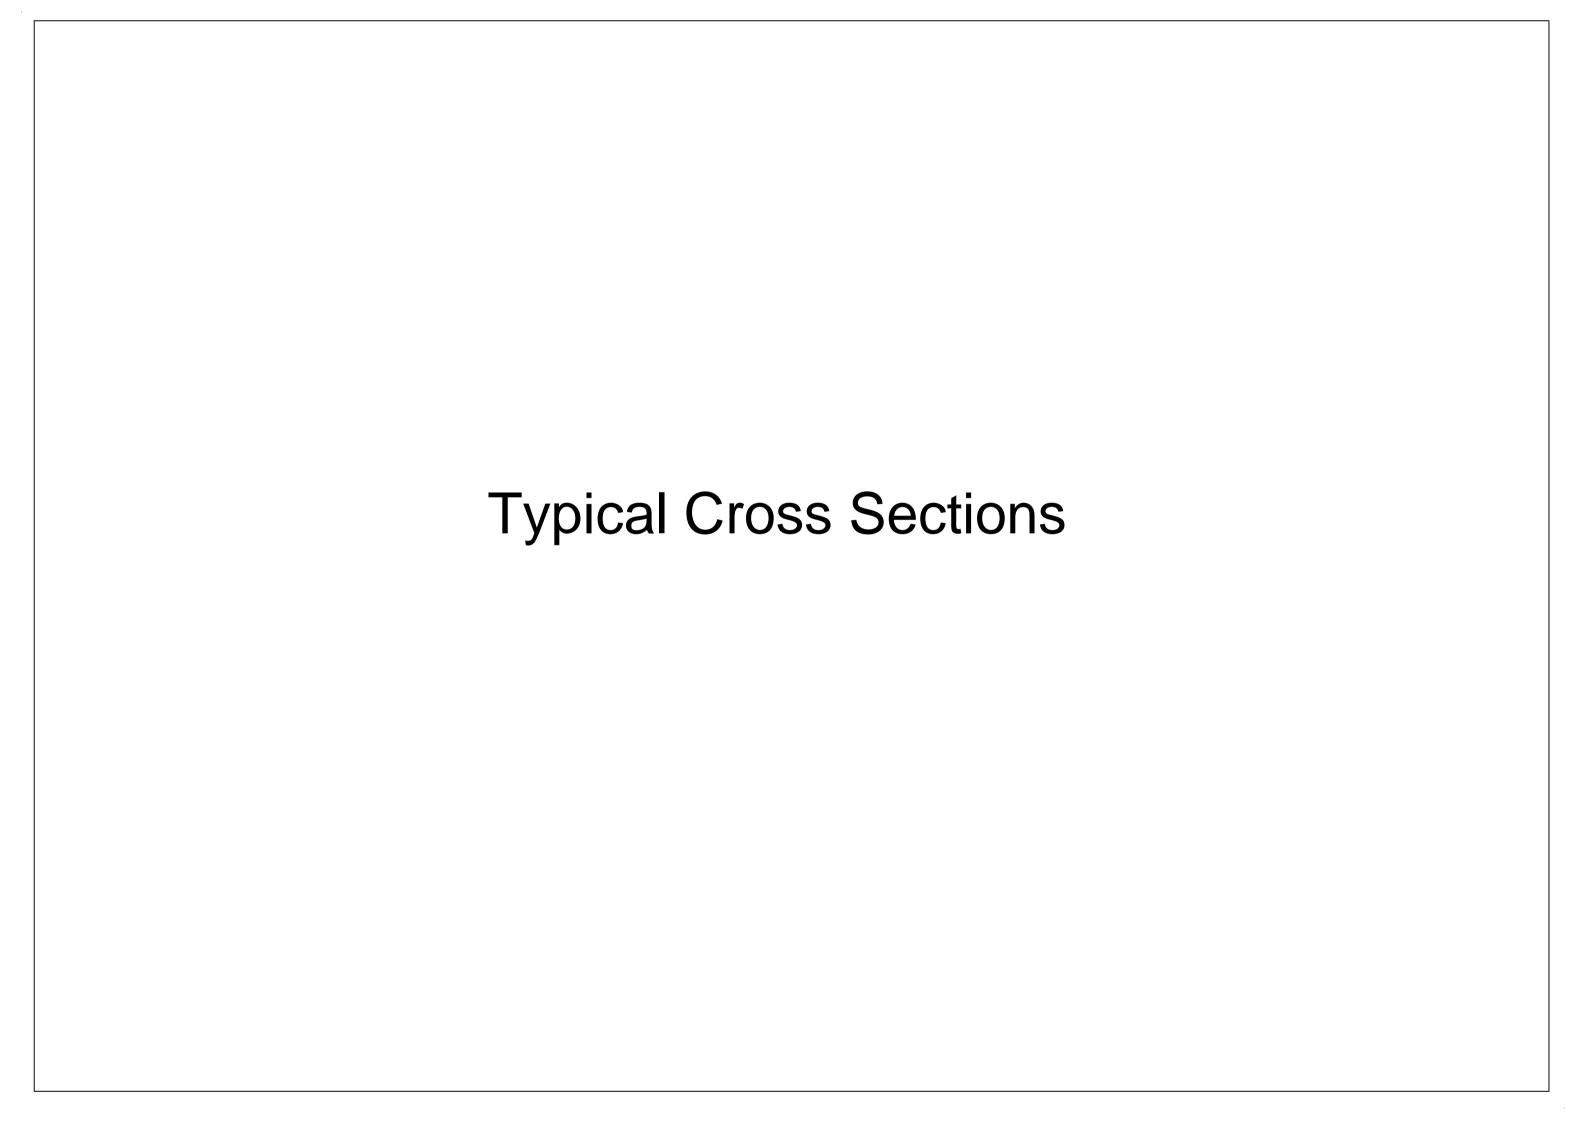

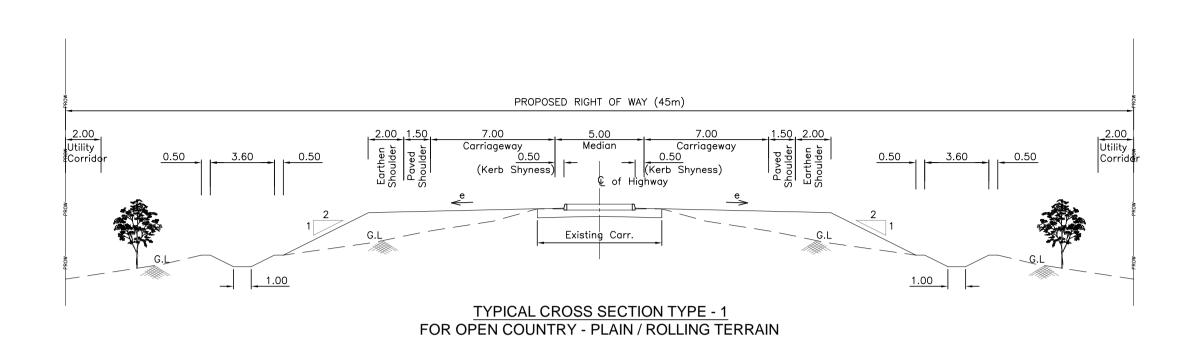

(RECONSTRUCTION OF EXISTING CARRIAGEWAY)

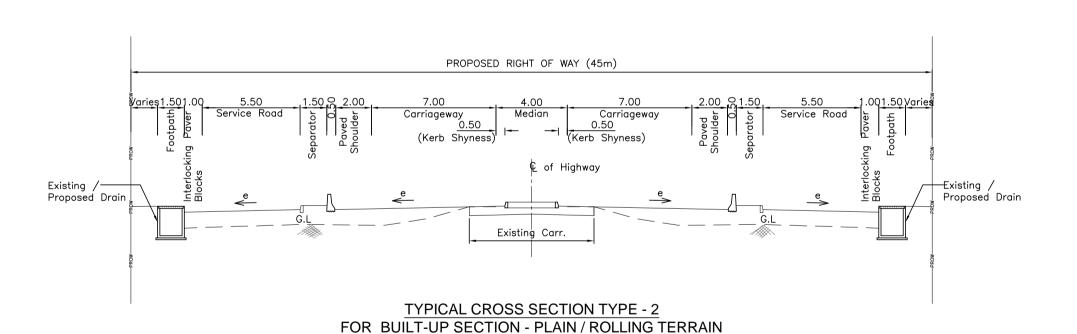

(RECONSTRUCTION OF EXISTING CARRIAGEWAY)

|    | NOTES:                       | REFERENCE DWGS.: |      |          |                      |       |      |      | CLIENT:                                       |
|----|------------------------------|------------------|------|----------|----------------------|-------|------|------|---|
| 1. | ALL DIMENSIONS ARE IN METERS |                  |      |          |                      |       |      |      |   |
|    |                              |                  |      |          |                      |       |      |      |   |
|    |                              |                  | R3   | 17/08/22 | FINAL DPR SUBMISSION | JJL   | CSB  | DMC  |   |
|    |                              |                  | R2   | 22/06/22 | FINAL DPR SUBMISSION | JJL   | CSB  | DMC  | CONSULT                                       |
|    |                              |                  | R1   | 19/05/22 | FINAL DPR SUBMISSION | JJL   | CSB  | DMC  |   |
|    |                              |                  | R0   | 11/03/22 | DPR SUBMISSION       | JJL   | CSB  | DMC  |   |
|    |                              |                  | REV. | DATE     | DESCRIPTION          | DRAWN | снк. | APP. | DISCLAIMER:<br>THIS DR<br>JOB MEI<br>OR INDII |
|    |                              |                  |      |          | REVISION INDEX       | ,     |      |      | OR INDIF                                      |

## National Highways Authority of India (Ministry of Road Transport and Highways)

(Ministry of Road Transport and Highways) G-5 & 6, Sector-10, Dwarka, New Delhi - 110075.

## consultant: FP Project Management

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### PROJECT :


WIDENING AND RECONSTRUCTION OF EXISTING TWO LANE CARRIAGEWAY TO FOUR LANE WITH PAVED SHOULDER INCLUDING CONSTRUCTION OF ROB IN MAKHU TOWN FROM KM. 170+000 TO KM. 171+900 OF NH-54 IN THE STATE OF PUNJAB ON EPC MODE


DRAWING TITLE : HARIKE - ZIRA - FARIDKOTE SECTION

TYPICAL CROSS SECTION
TCS TYPE - 1 AND TCS TYPE - 2

 SCALE:
 1:150
 PROJECT No.:
 165007

 FPI
 HW
 DD
 HZF
 TCS
 1025
 R3

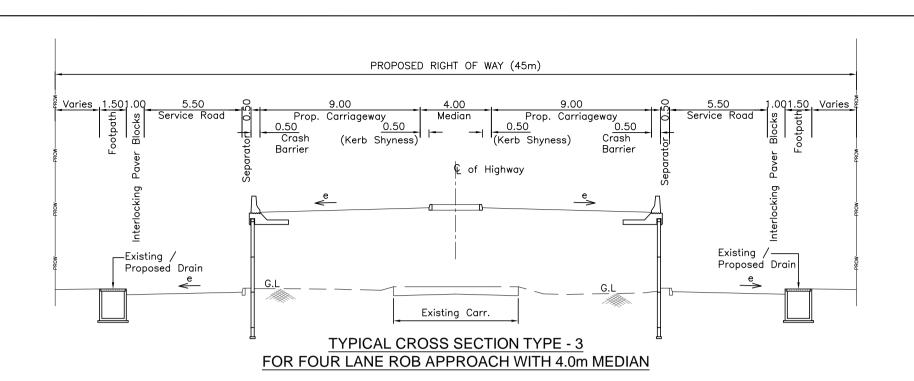

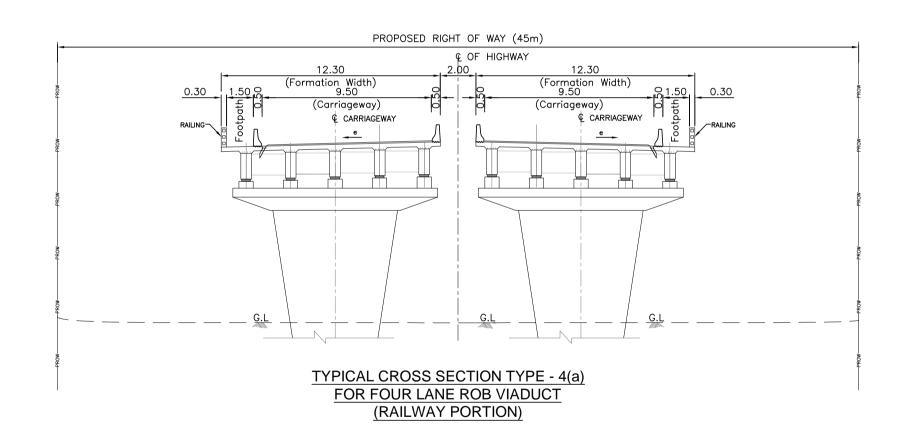

|   |                                |                  |      |          |                      |       |      |      | _        |
|---|--------------------------------|------------------|------|----------|----------------------|-------|------|------|----------|
|   | NOTES:                         | REFERENCE DWGS.: |      |          |                      |       |      |      | CLI      |
| 1 | . ALL DIMENSIONS ARE IN METERS |                  |      |          |                      |       |      |      |          |
|   |                                |                  |      |          |                      |       |      |      |          |
|   |                                |                  | R3   | 17/08/22 | FINAL DPR SUBMISSION | JJL   | CSB  | DMC  | <u> </u> |
|   |                                |                  | R2   | 22/06/22 | FINAL DPR SUBMISSION | JJL   | CSB  | DMC  | CO       |
|   |                                |                  | R1   | 19/05/22 | FINAL DPR SUBMISSION | JJL   | CSB  | DMC  | 1        |
|   |                                |                  | R0   | 11/03/22 | DPR SUBMISSION       | JJL   | CSB  | DMC  | 1        |
|   |                                |                  | REV. | DATE     | DESCRIPTION          | DRAWN | снк. | APP. | DISCLAI  |
|   |                                |                  |      | •        | REVISION INDEX       |       |      |      | 1        |

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(Ministry of Road Transport and Highways)
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## consultant: FP Project Management

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### PROJECT :


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DRAWING TITLE : HARIKE - ZIRA - FARIDKOTE SECTION

TYPICAL CROSS SECTION
TCS TYPE - 3 AND TCS TYPE - 4(a)

 SCALE:
 1:150
 PROJECT No.:
 165007

 FPI
 HW
 DD
 HZF
 TCS
 1026
 R3

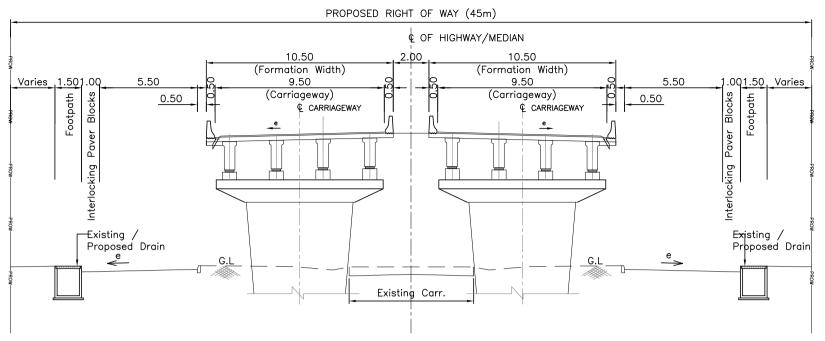

TYPICAL CROSS SECTION TYPE - 4(b)
FOR FOUR LANE ROB VIADUCT
(NON RAILWAY PORTION)

|    | NOTES:                       | REFERENCE DWGS.: |      |          |                      |       |      |      | CL    |
|----|------------------------------|------------------|------|----------|----------------------|-------|------|------|-------|
| 1. | ALL DIMENSIONS ARE IN METERS |                  |      |          |                      |       |      |      | ] 5   |
|    |                              |                  |      |          |                      |       |      |      |       |
|    |                              |                  | R3   | 17/08/22 | FINAL DPR SUBMISSION | JJL   | CSB  | DMC  | L     |
|    |                              |                  | R2   | 22/06/22 | FINAL DPR SUBMISSION | JJL   | CSB  | DMC  | C     |
|    |                              |                  | R1   | 19/05/22 | FINAL DPR SUBMISSION | JJL   | CSB  | DMC  |       |
|    |                              |                  | R0   | 11/03/22 | DPR SUBMISSION       | JJL   | CSB  | DMC  | 1     |
|    |                              |                  | REV. | DATE     | DESCRIPTION          | DRAWN | СНК. | APP. | DISCL |
|    |                              |                  |      |          | REVISION INDEX       |       |      |      | 1     |

# CLIENT:

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(Ministry of Road Transport and Highway G-5 & 6, Sector-10, Dwarka, New Delhi - 110075.

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Tel: +91-22-6660 3901 Fax: +91-22-6660 3902
E-mail: pfmumbai@fpindia.com www.fpindia.com


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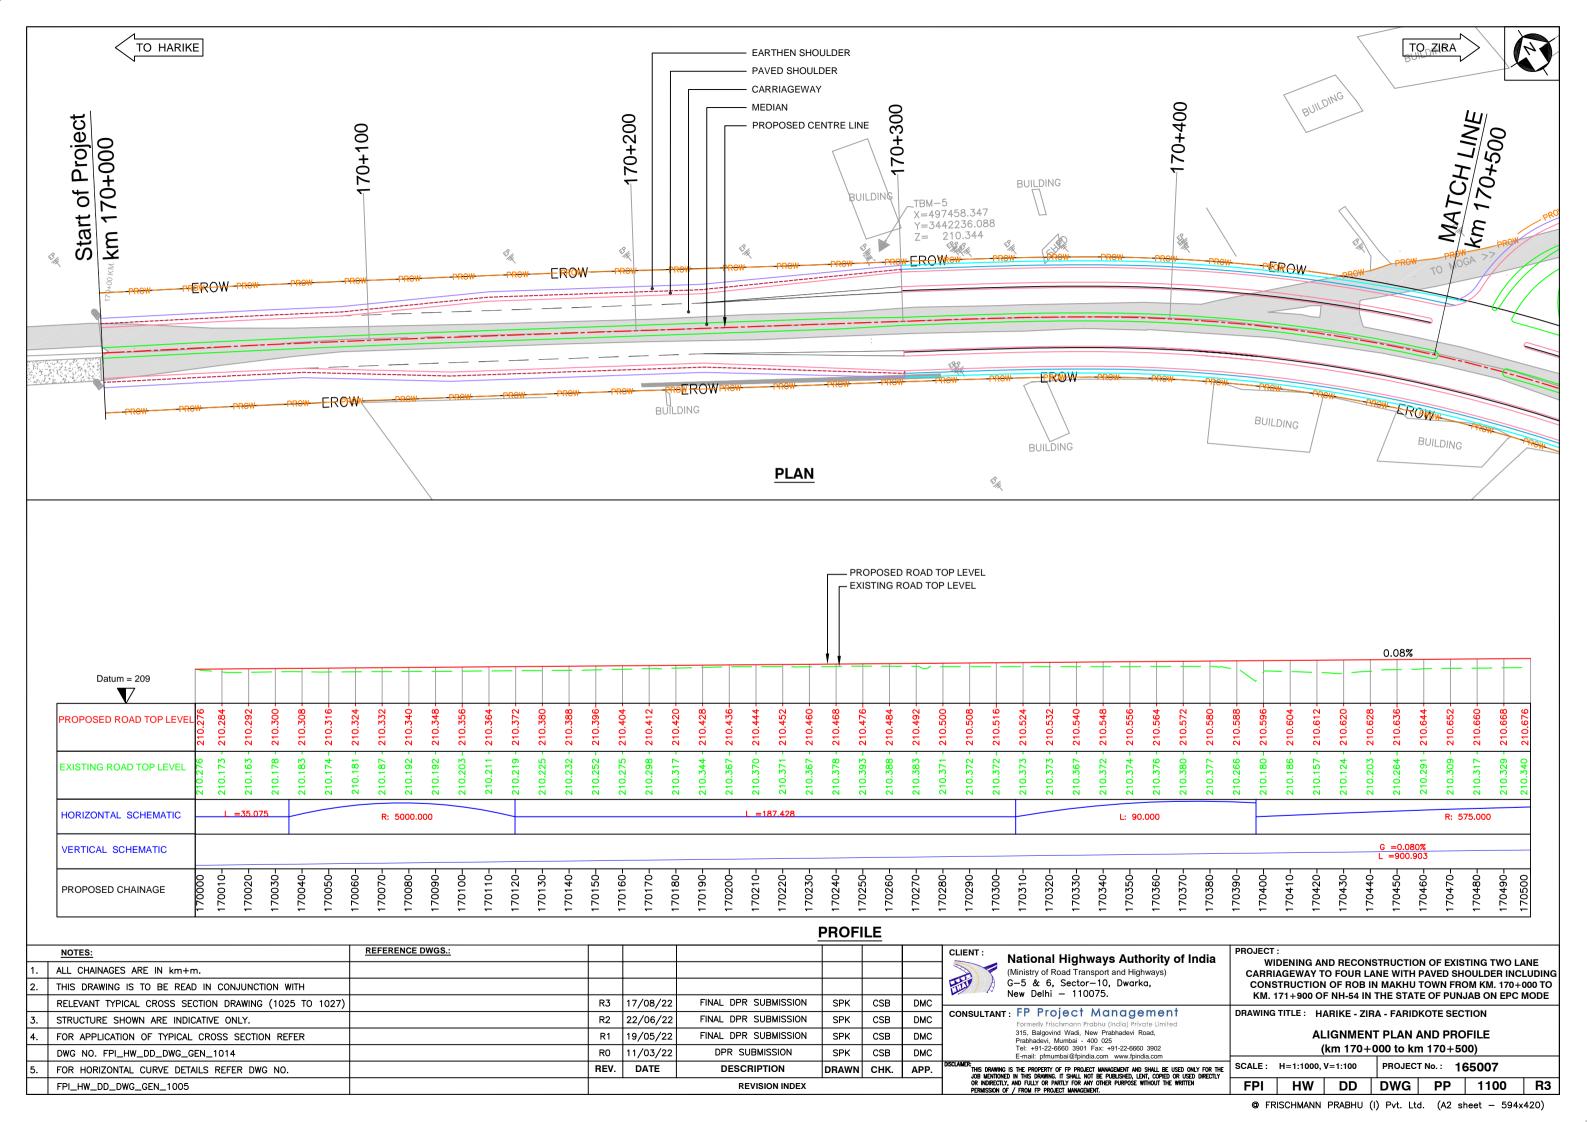
PROJECT:


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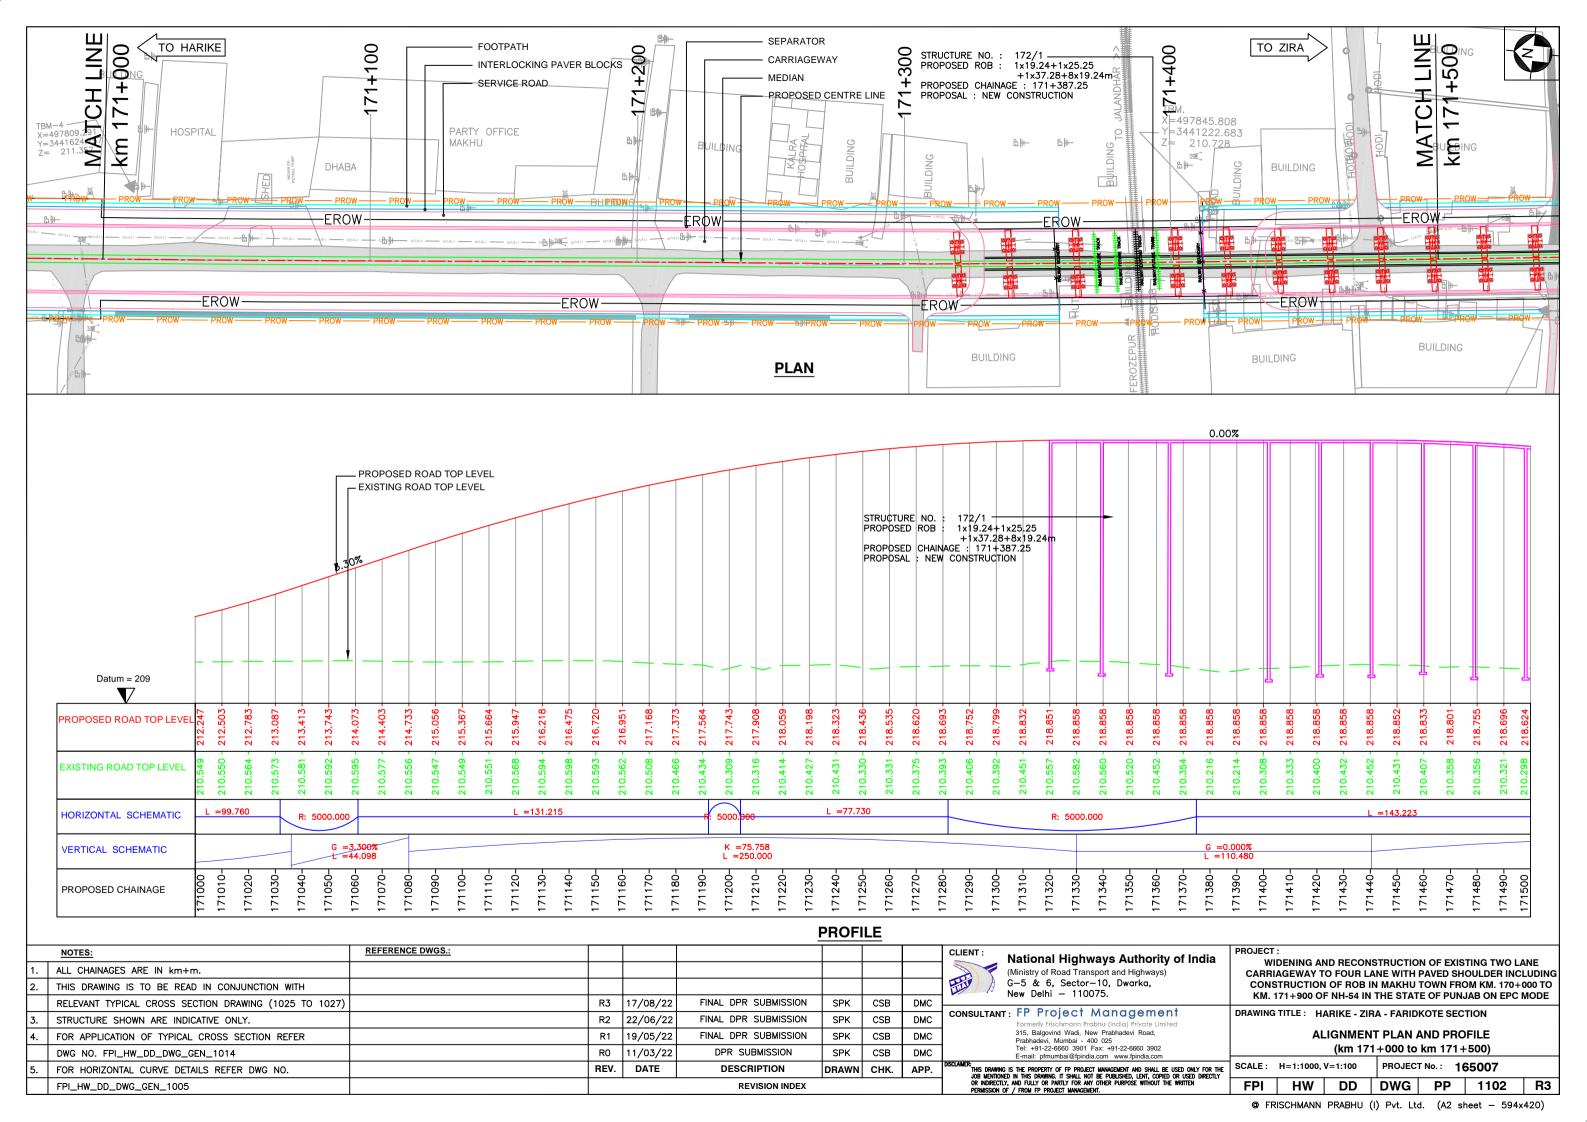
DRAWING TITLE: HARIKE - ZIRA - FARIDKOTE SECTION


TYPICAL CROSS SECTION
TCS TYPE - 4(b)







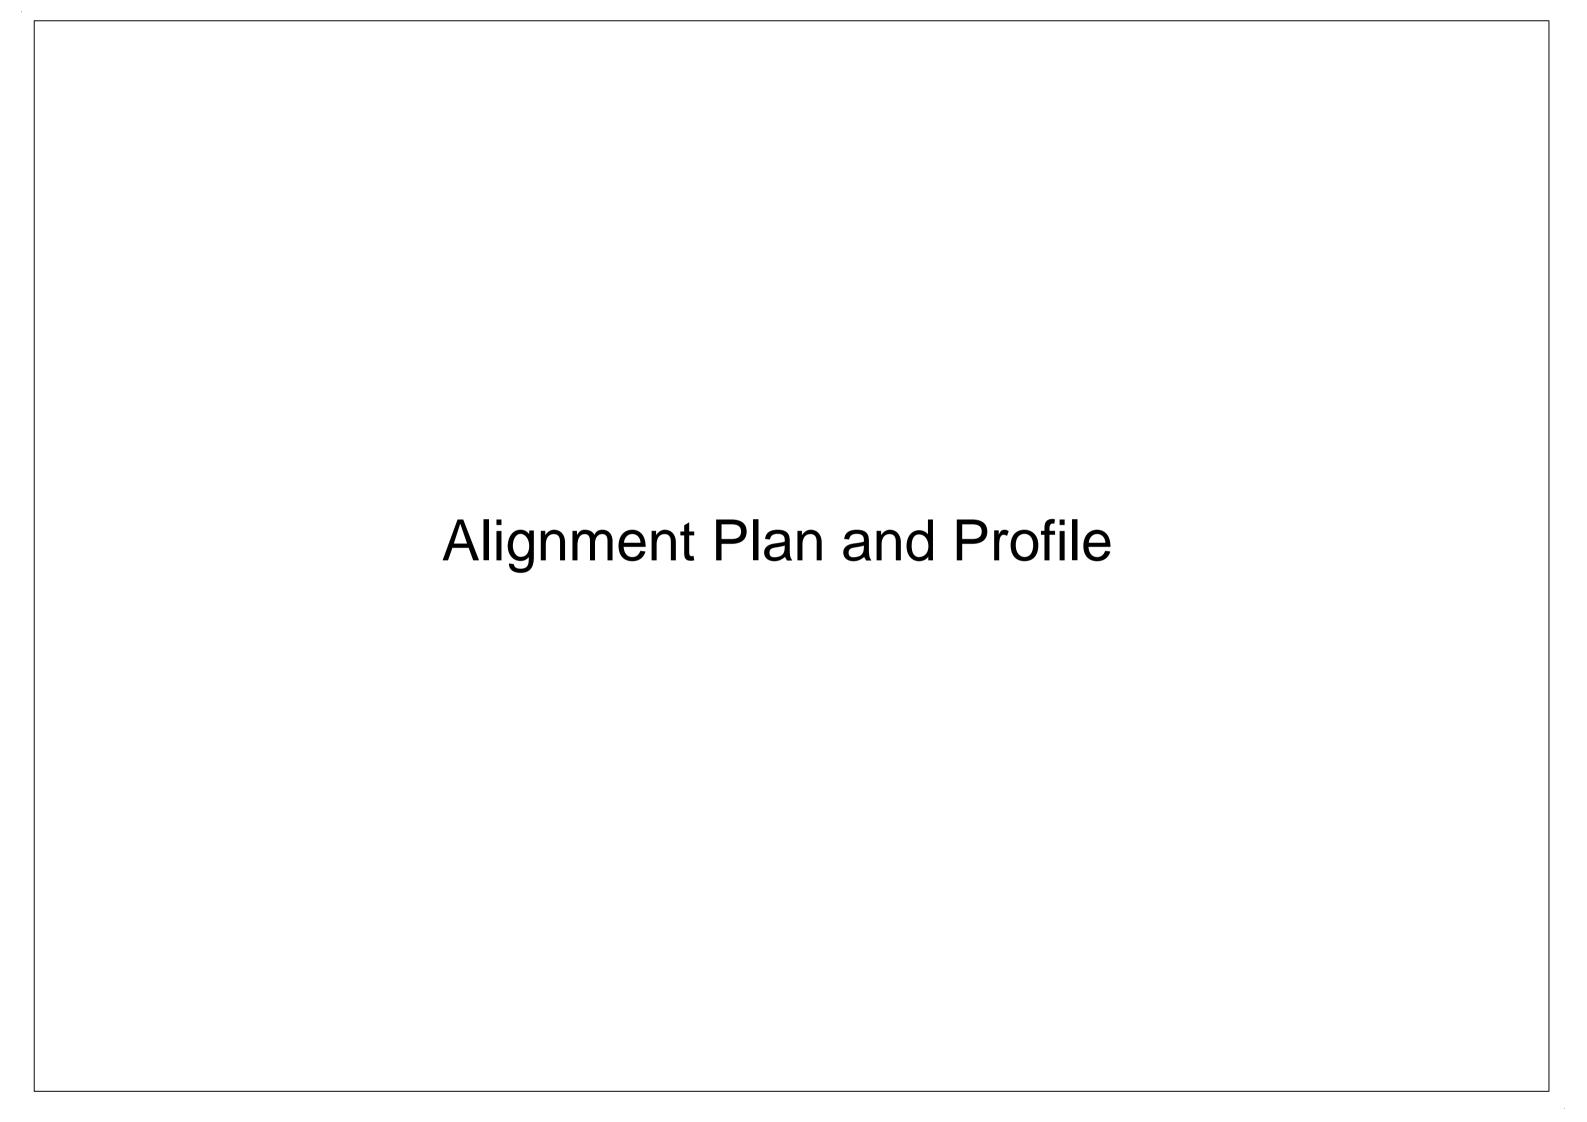


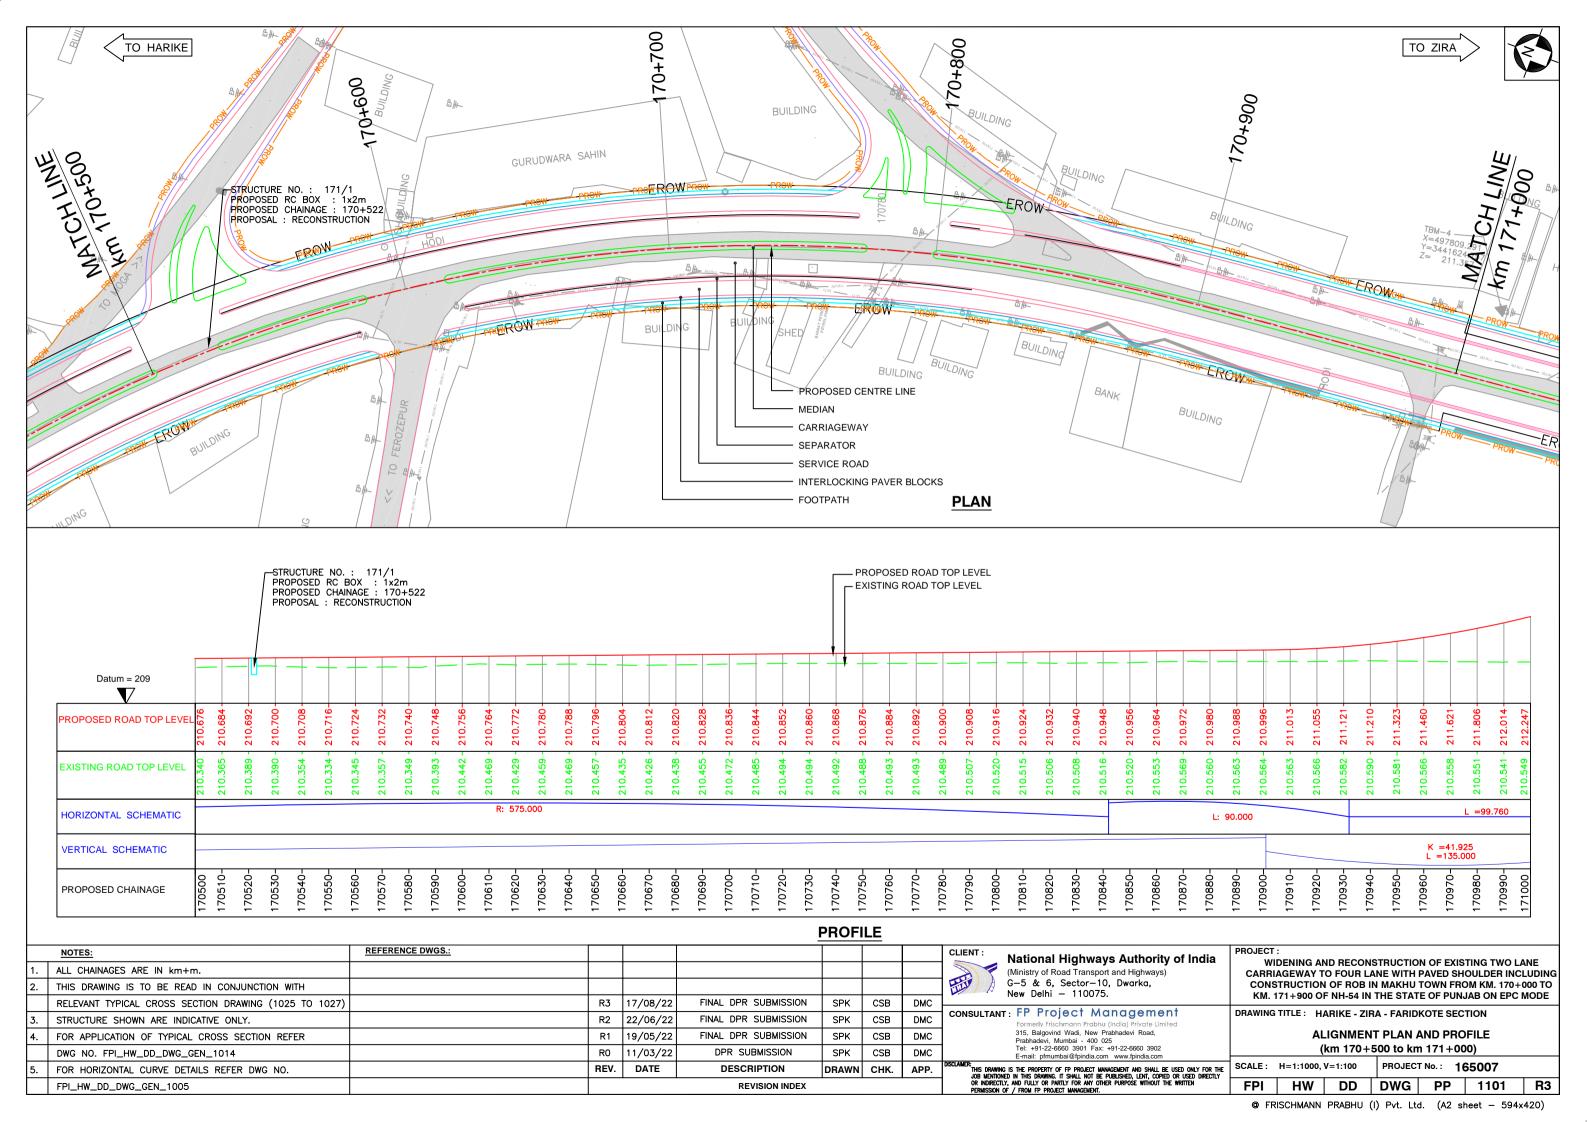


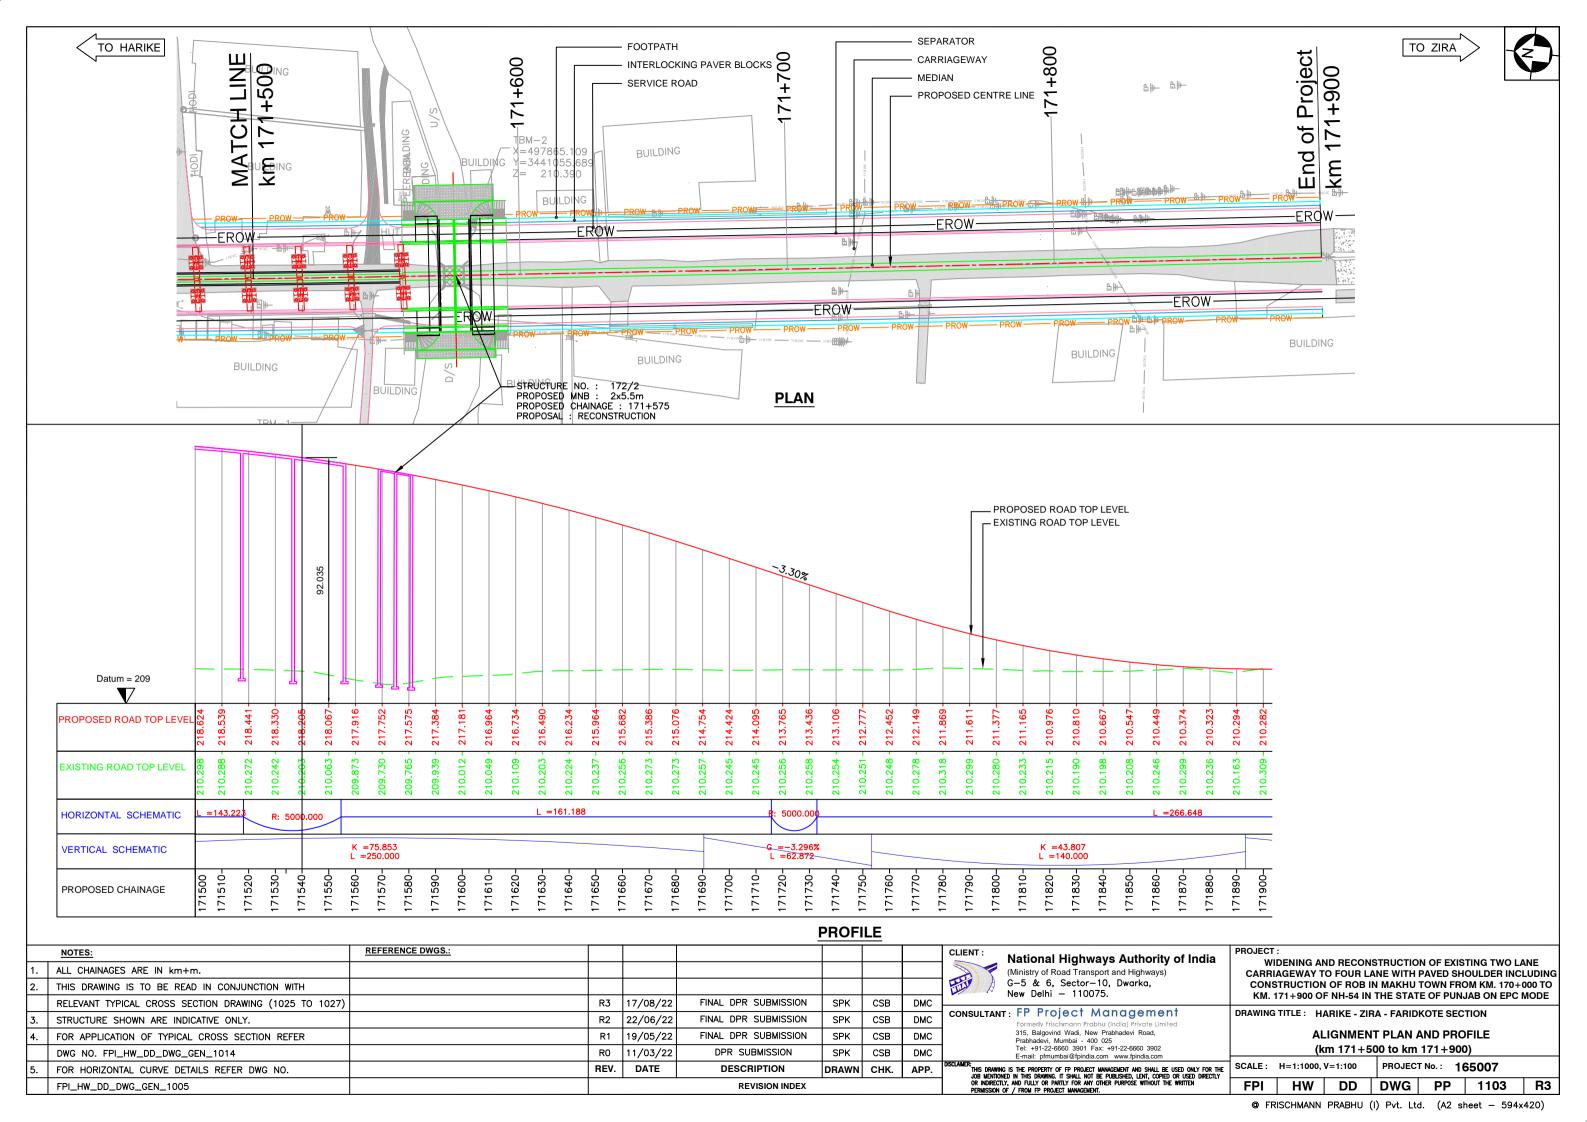

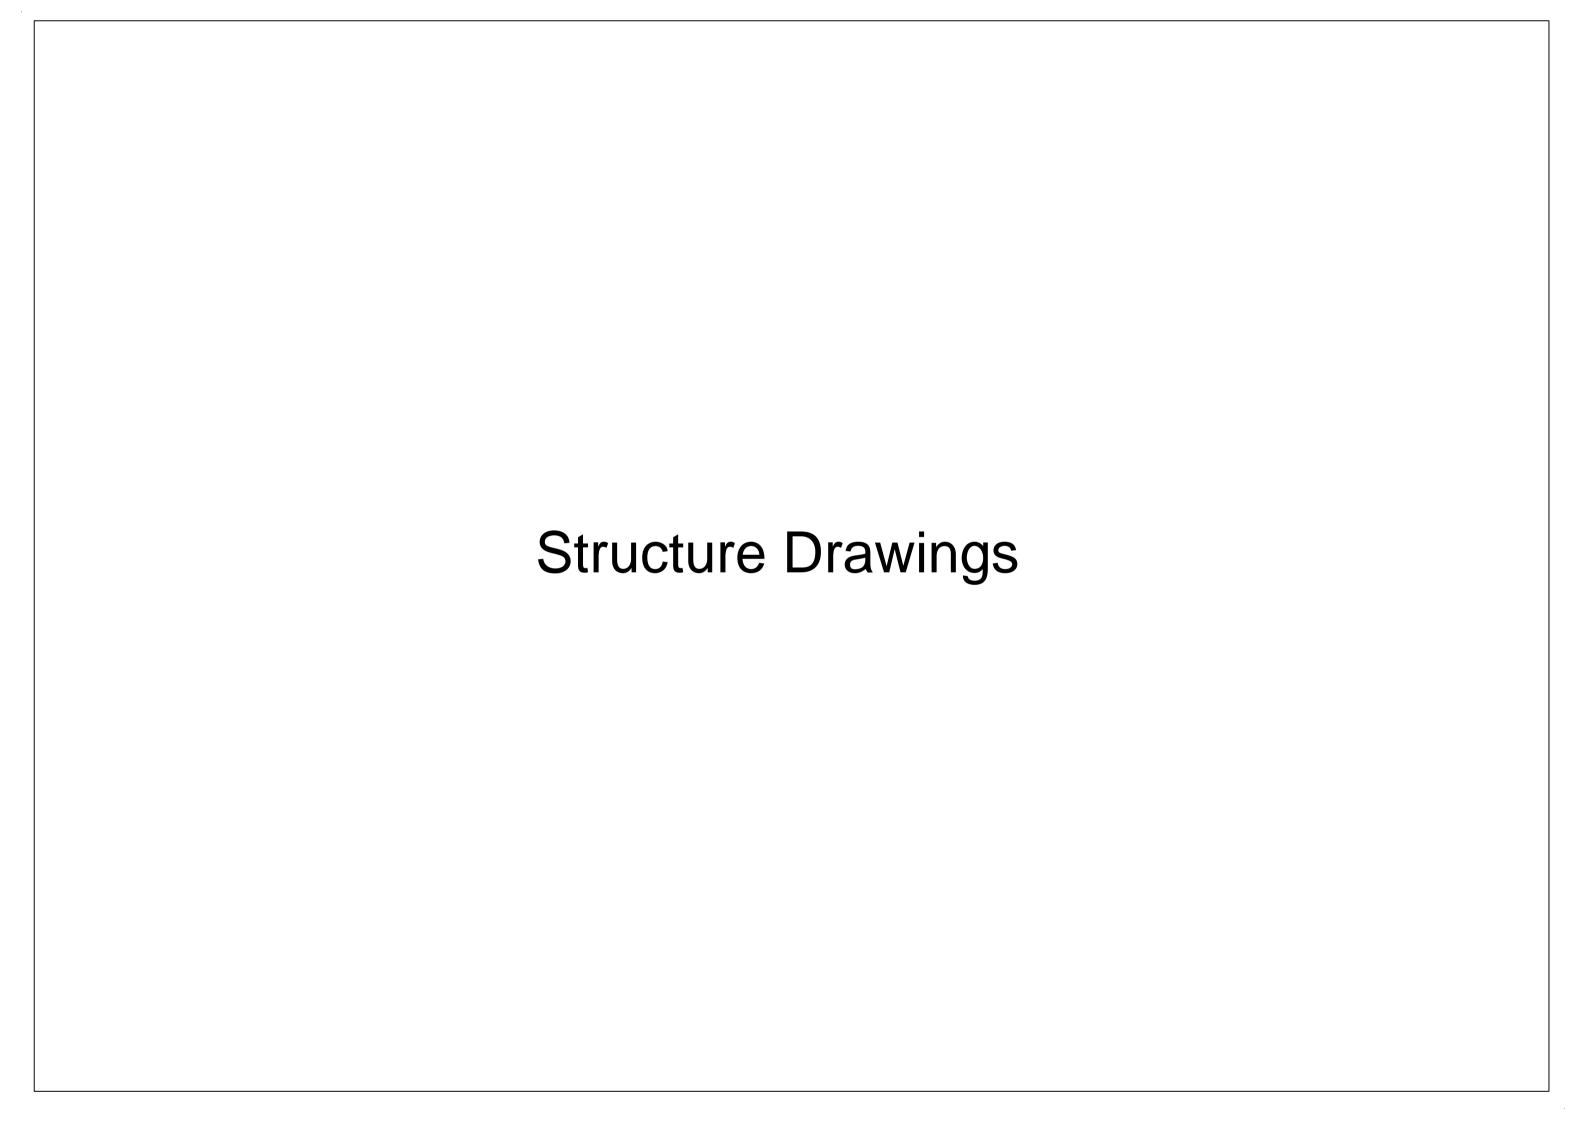

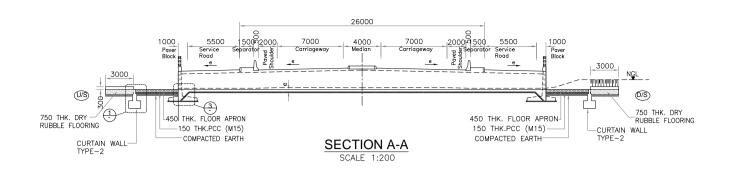

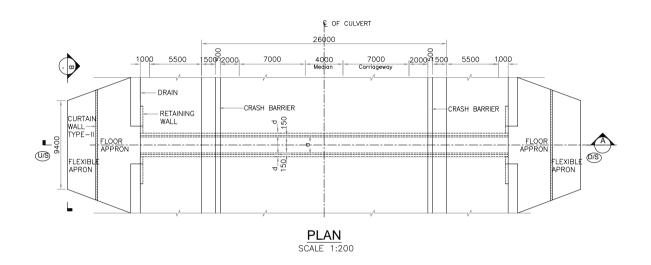

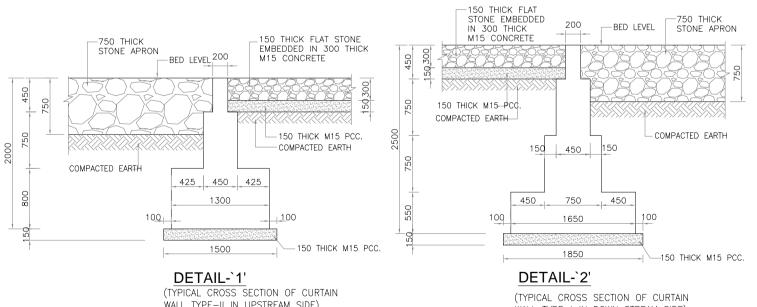

REFERENCE DWGS:

WALL TYPE-II IN UPSTREAM SIDE) SCALE 1:25

NOTES:

WALL TYPE-I IN DOWN STREAM SIDE) SCALE 1:25

R3 17/08/22

R2 22/06/22

R1 19/05/22


RO 11/03/22

REV. DATE

## - CONSTRUCTION JOINT -150x150 HALINCH (TYP) 150×150 -HAUNCH (TYP.) -CONSTRUCTION JOINT -100 THK, PCC M15

DETAIL-`4' SCALE 1:25


DETAIL-`5' SCALE 1:25

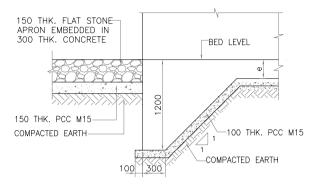


DETAIL-`3' SCALE 1:25

## NOTES:

- 1. ALL DIMENSIONS ARE IN mm AND LEVELS IN METERS UNLESS OTHERWISE MENTIONED.
- 2. THE STRUCTURE IS DESIGNED FOR IRC CLASS—A LOADING AND IRC CLASS 70R LOADING. THE CARRIAGEWAY LIVE LOAD COMBINATION SHALL BE CONSIDERED FOR DESIGN AS PER CLAUSE NO 204.3 OF IRC-6-2017
- 3. CONGESTION FACTOR AND SV LOADING IS CONSIIDERED AS PER CLAUSE NO 204.4 & 204.5 OF IRC-6-2017 RESPECTIVELY
- 4. CONCRETE FOR BOX STRUCTURE AND RETURN WALL SHALL BE DESIGN MIX WITH A MINIMUM
  28 DAYS CHARACTERISTIC. STRENGTH OF
- 5. THE INTENTIONED STEEL SHALL BE H.Y.S.D. BARS (GRADE DESIGNATION FE-500/500D) CONFORMING TO IS:1786.
- 6. 65mm THK. WEARING COAT SHALL CONSIST OF MASTIC ASPHALT 15mm THK. AND TWO LAYERS OF ASPHALTIC CONC. 25mm EACH AS PER MOSRT&H STANDARD.
- 7. BACK FILLING MATERIAL SHALL CONFORM TO CL:305.2.1.5 OF MORT&H SPECIFICATION.
- 8. 300mm THICK FILTER MEDIA SHALL BE PROVIDED BEHIND VERTICAL WALL OF BOX CULVERT & RETAINING WALL
- 9. WEEP HOLES OF 100mm DIA. OF PVC PIPE SHALL BE PROVIDED IN STAGGERED MANNER AT A SPACING NOT MORE THAN 1000mm IN BOTH VERTICAL & HORIZONTAL DIRECTION AT A SLOPE OF 1 IN 20.

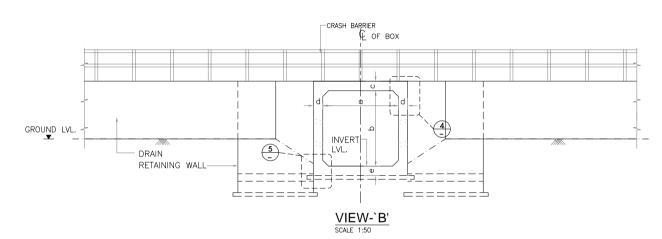

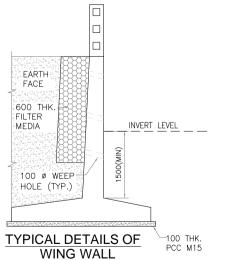

SCALE 1:40

JJL

JJL

JJL SRD

DMC

SRD DMC

JJL SRD DMC

DRAWN CHK. APP.

FINAL DPR SUBMISSION

FINAL DPR SUBMISSION

FINAL DPR SUBMISSION

DPR SUBMISSION

DESCRIPTION

REVISION INDEX

TABLE SHOWING SALIENT DIMENSIONS

| PROP. CH. | SPAN  | a<br>(mm) | b<br>(mm) | c<br>(mm) | d<br>(mm) | e<br>(mm) |
|-----------|-------|-----------|-----------|-----------|-----------|-----------|
| 170+522   | 1X2X2 | 2000      | 2000      | 250       | 250       | 250       |

| CLIENT:     | Nationa<br>(Ministry of<br>G-5 & 6,<br>New Delhi |
|-------------|--|
| CONSULTANT: | FP Pr  |

al Highways Authority of India f Road Transport and Highway Sector-10, Dwarka, - 110075.

roject Management

315, Balgovind Wadi, New Prabhadevi Road, Prabhadevi, Mumbai - 400 025 Tel: +91-22-6660 3901 Fax: +91-22-6660 3902 E-mail: pfmumbai@fpindia.com www.fpindia.com THIS DRAWING IS THE PROPERTY OF FP PROJECT MANAGEMENT AND SHALL BE USED ONLY FOR THE JOB MENTIONED IN THIS DRAWING, IT SHALL NOT BE PUBLISHED, LENT, COPIED OR USED DIRECTLY OR INDIRECTLY, AND FULLY OR PARTLY

WIDENING AND RECONSTRUCTION OF EXISTING TWO LANE CARRIAGEWAY TO FOUR LANE WITH PAVED SHOULDER INCLUDING CONSTRUCTION OF ROB IN MAKHU TOWN FROM KM, 170+000 TO KM. 171+900 OF NH-54 IN THE STATE OF PUNJAB ON EPC MODE

HARIKE - ZIRA - FARIDKOTE SECTION

TYPICAL GENERAL ARRANGEMENT DRAWING OF BOX CULVERT (WITHOUT CUSHION)

SCALE:- AS SHOWN PROJECT NO. 165007 ST DD DWG HZF 5001 R3

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